

MECHANICAL NOTES:


- 1. ALL HVAC EQUIPMENT AND DUCTWORK TO BE INSTALLED IN ACCORDANCE WITH STATE AND LOCAL CODES.
- 2. THE CONTRACTOR SHALL COORDINATE THE LOCATION OF ALL DUCTWORK, PIPING, AND ELECTRICAL REQUIREMENTS WITH ALL OTHER TRADES PRIOR TO BEGINNING INSTALLATION TO AVOID CONFLICTS AND INTERFERENCE WITH OTHER TRADES.
- 3. ALL EQUIPMENT TO BE INSTALLED AS SUGGESTED BY MANUFACTURER.
- 4. INSULATE SUPPLY AND RETURN DUCTWORK LOCATED IN UNCONDITIONED SPACES BY WRAPPING WITH INSULATION WITH A MINIMUM INSTALLED R-VALUE OF 5.0. DIMENSIONS SHOWN ARE INSIDE CLEAR AREA DIMENSIONS.
- 5. FIRST 10' FROM THE HVAC UNIT OF EXPOSED INTERIOR DUCTWORK MUST BE INSULATED WITH 1" DUCT LINER.
- 6. EQUIP RETURN AIR GRILLES WITH FILTERS. INSTALL WASHABLE SCREEN FILTER ON OUTSIDE AIR INTAKE OF ROOF TOP
- 7. MECHANICAL SYSTEM TO BE BALANCED AND TESTED AFTER INSTALLATION TO ASSURE PROPER OPERATION.
- 8. COORDINATE EXACT LOCATION OF THERMOSTATS WITH OWNER.
- 9. BATHROOM EXHAUST FANS ARE TO BE FURNISHED, INSTALLED AND DUCTED TO OUTDOORS BY THE MECHANICAL CONTRACTOR. EXHAUST FAN TO BE WIRED BY THE ELECTRICAL CONTRACTOR.
- 10. SMOKE DETECTORS ARE TO BE PROVIDED IN RETURN AIR DUCT OF EACH UNIT AHEAD OF MAKE—UP AIR CONNECTIONS TO SHUT DOWN THE UNIT IN CASE OF FIRE.
- 11. DUCT SMOKE DETECTORS ARE TO BE CONNECTED TO FIRE ALARM.
- 12. EXHAUST FAN DISCHARGE TO BE AT LEAST TEN FEET AWAY FROM HVAC FRESH AIR IN-TAKE.
- 13. GAS PIPING BASED ON 2 PSI GAS PRESSURE. VERIFY ALL GAS LINES SIZES WITH GAS COMPANY.
- 14. ALL GAS PIPING TO BE BLACK STEEL PIPING WITH PROTECTIVE PAINT.
- 15. GAS REGULATORS FOR HVAC EQUIPMENT TO BE PROVIDED AND INSTALLED BY MECHANICAL CONTRACTOR.
- 16. FINAL UTILITY CONNECTIONS (GAS, ELECTRIC, ETC.) TO EQUIPMENT SHALL BE MADE BY THE CONTRACTOR INSTALLING THE EQUIPMENT REQUIRING THE UTILITIES.
- 17. DUCT DRAWINGS ARE DIAGRAMMATIC AND ARE INTENDED TO SHOW THE INTENT OF THE ENGINEER. THE CONTRACTOR SHALL BE RESPONSIBLE FOR PROVIDING ANY ADDITIONAL TRANSITIONS, OFFSETS, OR TURNS, IN THE DUCTWORK AND/OR PIPING, NOT SHOWN BUT REQUIRED FOR A COMPLETE AND OPERATING SYSTEM.
- 18. ALL DUCTWORK SHALL BE INSTALLED TIGHT AGAINST THE STRUCTURE UNLESS OTHERWISE NOTED OR SHOWN.
- 19. AIR DISTRIBUTION LOCATIONS SHOWN ON MECHANICAL PLANS ARE APPROXIMATE, SEE ARCHITECTURAL REFLECTED CEILING PLANS FOR ACTUAL LOCATIONS.
- 20. REFER TO ARCHITECTURAL DRAWINGS FOR DIMENSIONED LOCATIONS OF WALLS AND PARTITIONS AND FOR PARTITION THICKNESS AND CONSTRUCTION MATERIALS.
- 21. ELECTRICAL POWER REQUIREMENTS ARE BASED ON MANUFACTURER'S PUBLISHED DATA. IF ACTUAL UNIT IS A DIFFERENT MANUFACTURER OR THE ACTUAL PURCHASED UNIT(S) OTHERWISE HAVE DIFFERENT ELECTRICAL LOAD (MCA) OR CIRCUIT BREAKER (MCB) REQUIREMENTS THAN WHAT IS PUBLISHED ON THE DRAWING SCHEDULE, THE MECHANICAL CONTRACTOR MUST SUBMIT THE CORRECT DATA IN WRITING TO THE GENERAL CONTRACTOR AND ELECTRICAL CONTRACTOR (IF KNOWN). IT IS THE MECHANICAL CONTRACTOR'S RESPONSIBILITY TO ENSURE THAT THE GC AND ELECTRICAL CONTRACTOR ARE NOTIFIED OF CHANGES IN THE MECHANICAL EQUIPMENT, WHICH WILL CHANGE THE ELECTRICAL WIRING, BREAKER SIZES OR QUANTITY OF
- 22. OWNER TO SUPPLY FAN AND STAIGHT DUCTWORK FOR PAINT BOOTH EXHAUST. COORDINATE DUCT AND WALL OPENING SIZE WITH OWNER PRIOR TO CONSTRUCTION

SYMBO	OLS & ABBREVIATIONS LEGEND						
SYMBOL	DESCRIPTION						
Ū	THERMOSTAT						
\boxtimes	CEILING SUPPLY DIFFUSER						
	CEILING RETURN GRILLE						
	SIDEWALL SUPPLY DIFFUSER						
1-4	SIDEWALL RETURN OR EXHAUST GRILLE						
\boxtimes	SUPPLY DUCT SECTION						
	RETURN DUCT SECTION						
CFM	CUBIC FEET PER MINUTE						
	NATURAL GAS						
***************************************	UNION						
ø	DIAMETER OR POWER PHASE						
O.A.	OUTSIDE AIR						
R.A.	return air						
S.A.	SUPPLY AIR						
A.F.F.	ABOVE FINISHED FLOOR						
8	EXHAUST FAN						
(D)	DUCT MOUNTED SMOKE DETECTOR						

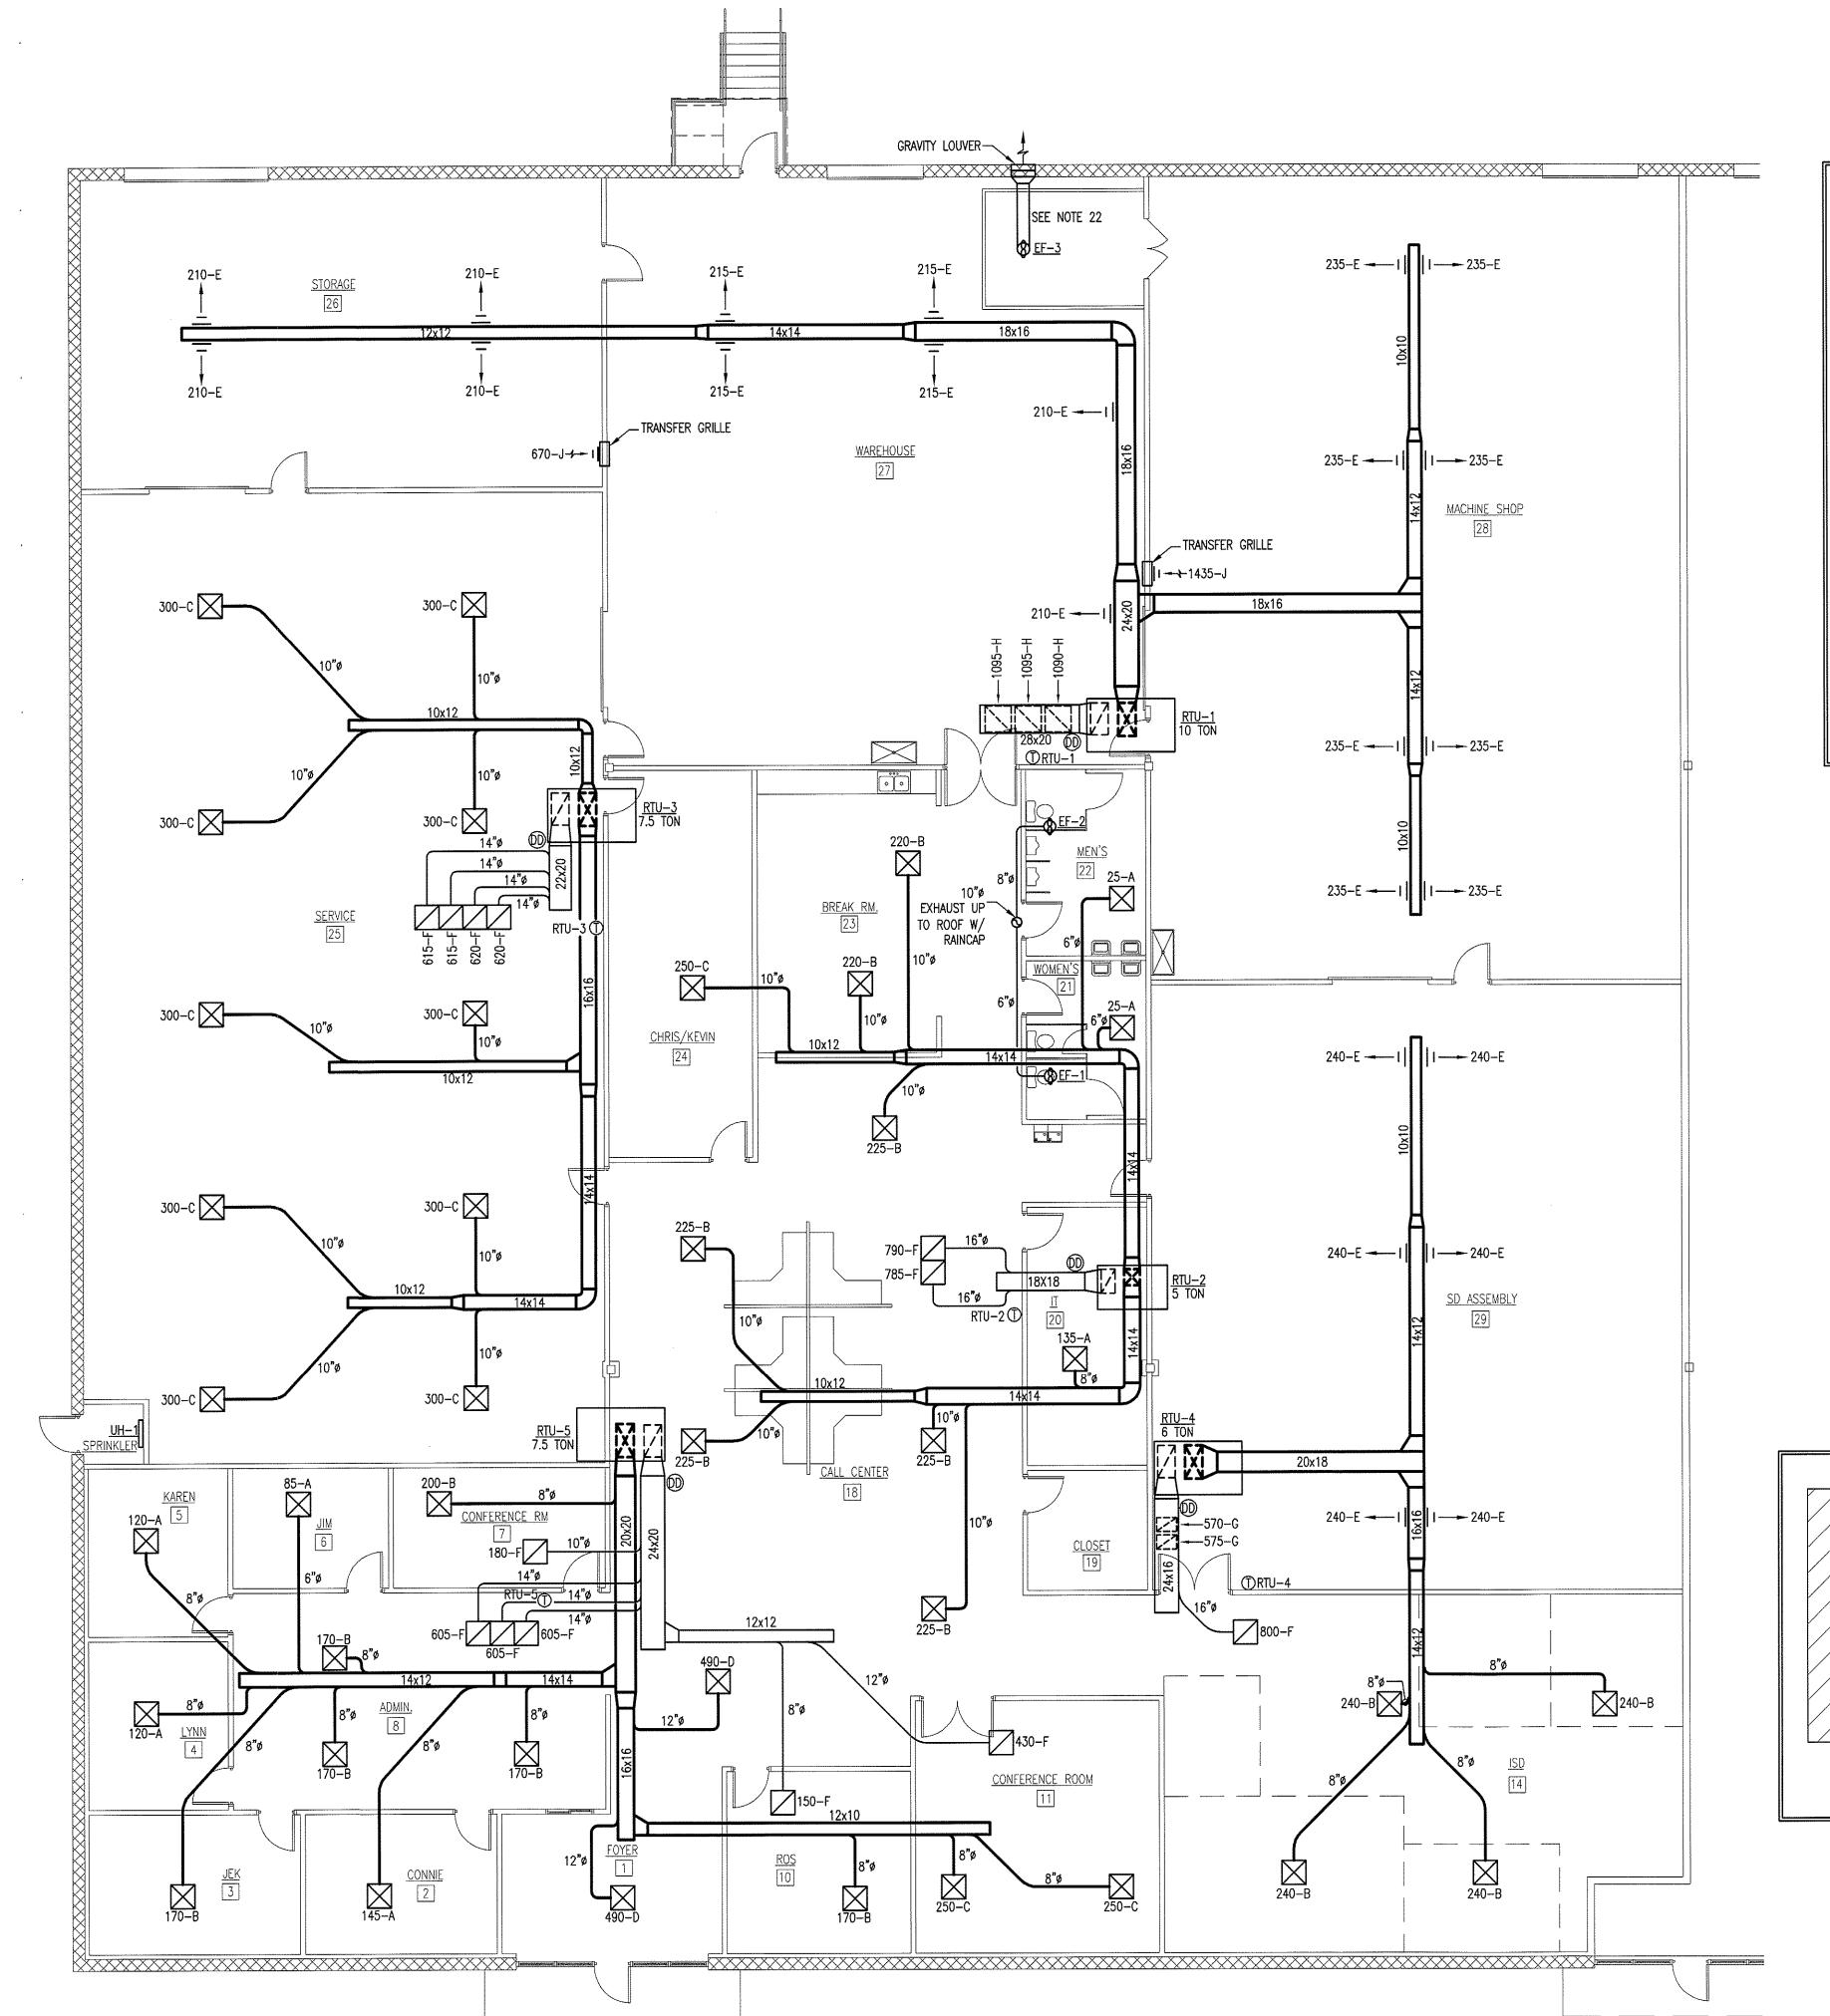

MECHANICAL PLAN

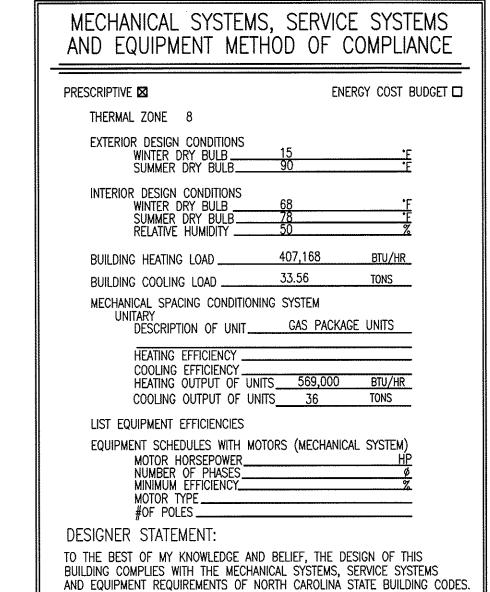

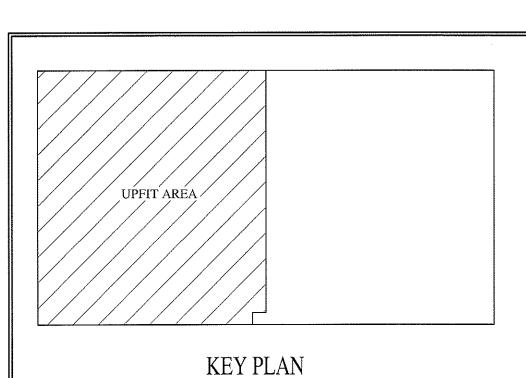



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Alamance

Consulting Engineers

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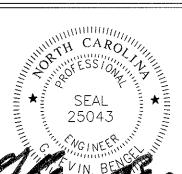
Phone: (336) 449-4558 Fax: (336) 449-5732

Ski

DRAWING NAME

MECHANICAL

PLAN



DRAWN
MJW
CHECKED

DATE
4/1/09
SCALE
AS NOTED
JOB NO.

M-1

9024

		OUTSIDE A	IR CALCU	JLATIONS (RTI	J-1)		
OCCUPANCY CLASSIFICATION (PER TABLE 403.3)	NET (GROSS) SQUARE FOOTAGE	OCCUPANCY LOAD PERSONS PER 1,000 S.F.	CALCULATED # OF PEOPLE	OUTSIDE AIR REQUIRED PER PERSON (CFM)	OUTSIDE AIR REQUIRED PER S.F. (CFM)	OUTSIDE AIR REQUIRED (CFM)	OUTSIDE AIR PROVIDED (CFM)
MACHINE SHOP 28	(2954)		_		.15	443	445
STORAGE 26	(1116)				.15	167	170
WAREHOUSE 27	(2054)				.05	103	105
				_	, TOTAL OUTSIDE AIR	713	720

		OUTSIDE A	IR CALCU	JLATIONS (RT	J-2)		
OCCUPANCY CLASSIFICATION (PER TABLE 403.3)	NET (GROSS) SQUARE FOOTAGE	OCCUPANCY LOAD PERSONS PER 1,000 S.F.	CALCULATED # OF PEOPLE	OUTSIDE AIR REQUIRED PER PERSON (CFM)	OUTSIDE AIR REQUIRED PER S.F. (CFM)	OUTSIDE AIR REQUIRED (CFM)	OUTSIDE AIR PROVIDED (CFM)
CALL CENTER 18	(1897)	-		_	.05	107	110
OPEN OFFICE	221	7	6	20	_	120	120
OFFICE 24	290	7	2	20		40	40
IT 20	(215)	-	_	•••	.15	32	35
BREAK ROOM 23	263	30 .	8	15		120	120
				-	TOTAL OUTSIDE AIR	419	425


		OUTSIDE A	IR CALCU	JLATIONS (RTI	J-3)		
OCCUPANCY CLASSIFICATION (PER TABLE 403.3)	NET (GROSS) SQUARE FOOTAGE	OCCUPANCY LOAD PERSONS PER 1,000 S.F.	CALCULATED # OF PEOPLE		OUTSIDE AIR REQUIRED PER S.F. (CFM)	OUTSIDE AIR REQUIRED (CFM)	OUTSIDE AIR PROVIDED (CFM)
SERVICE 25	(3510)	-	_		.15	527	530
					TOTAL OUTSIDE AIR	527	530


		OUTSIDE A	IR CALCU	JLATIONS (RTI	J-4)		
OCCUPANCY CLASSIFICATION (PER TABLE 403.3)	NET (GROSS) SQUARE FOOTAGE	OCCUPANCY LOAD PERSONS PER 1,000 S.F.	CALCULATED # OF PEOPLE	OUTSIDE AIR REQUIRED PER PERSON (CFM)	OUTSIDE AIR REQUIRED PER S.F. (CFM)	OUTSIDE AIR REQUIRED (CFM)	OUTSIDE AIR PROVIDED (CFM)
SD ASSEMBLY 29	(2227)	_	****		.15	334	335
OPEN OFFICE (ISD)	929	7	6	20		120	120
					TOTAL OUTSIDE AIR	454	455


		OUTSIDE A	IR CALCU	JLATIONS (RT	U-5)		
OCCUPANCY CLASSIFICATION (PER TABLE 403.3)	NET (GROSS) SQUARE FOOTAGE	OCCUPANCY LOAD PERSONS PER 1,000 S.F.	CALCULATED # OF PEOPLE	OUTSIDE AIR REQUIRED PER PERSON (CFM)	OUTSIDE AIR REQUIRED . PER S.F. (CFM)	OUTSIDE AIR REQUIRED (CFM)	OUTSIDE AIR PROVIDED (CFM
OFFICE 2	140	7	1	20		20	20
OFFICE 3	155	7	1	20	_	20	20
OFFICE 4	122	7	1	20	_	20	20
OFFICE 5	122	7	1	20		20	20
OFFICE 6	98	7	1	20	_	20	20
ADMINISTRATION 8	420	7	3	20		60	60
OFFICE 10	175	7	1	20	_	20	20
CONFERENCE ROOM 11	320	50	16	10*	-	160	160
CONFERENCE ROOM 7	133	50	7	10*		70	70
entry/foyer	(251)	· •••		_	.05	13	15
					TOTAL OUTSIDE AIR	423	425

			EXHAUST	r FAN	SCHED	ULE		WIVE TO SERVICE TO SER		
MARK	MANUFACTURER	MODEL	TYPE	CFM	SP	MOTOR	POWER	SONES	WATTS	CONTROL
EF-1	GREENHECK	SP-A190	CEILING EXHAUST	150	0.125" W.G.	FHP	120V/1ø	2.9	113	WALL SWITCH
EF-2	GREENHECK	SP-A250	CEILING EXHAUST	225	0.125" W.G.	FHP	120V/1ø	3.0	83	WALL SWITCH
EF-3	*	*	EXHAUST	*	*	*	208/3ø	*	*	WALL SWITCH

* OWNER TO FURNISH AND INSTALL

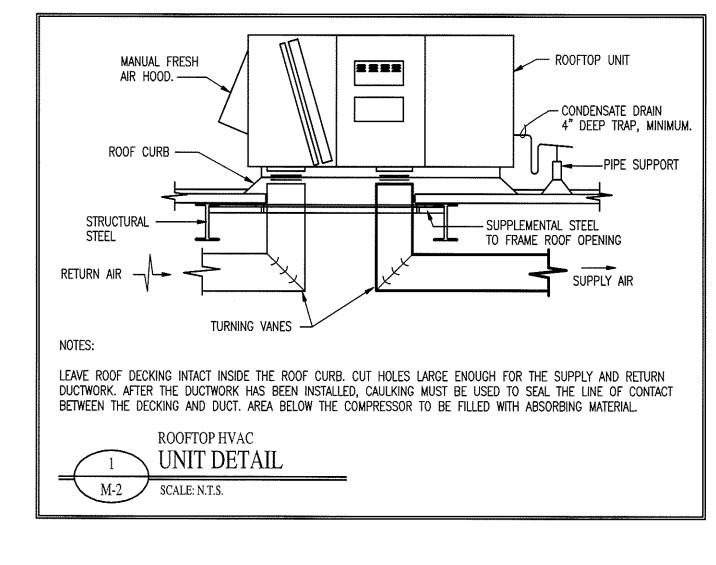

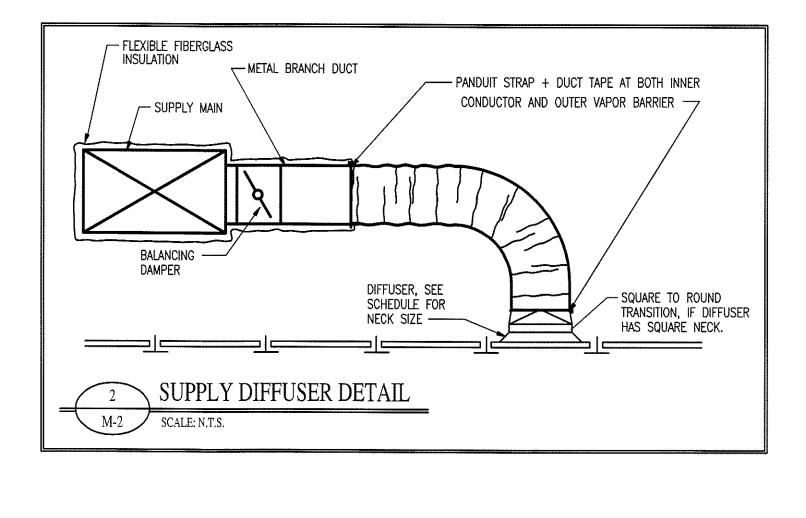

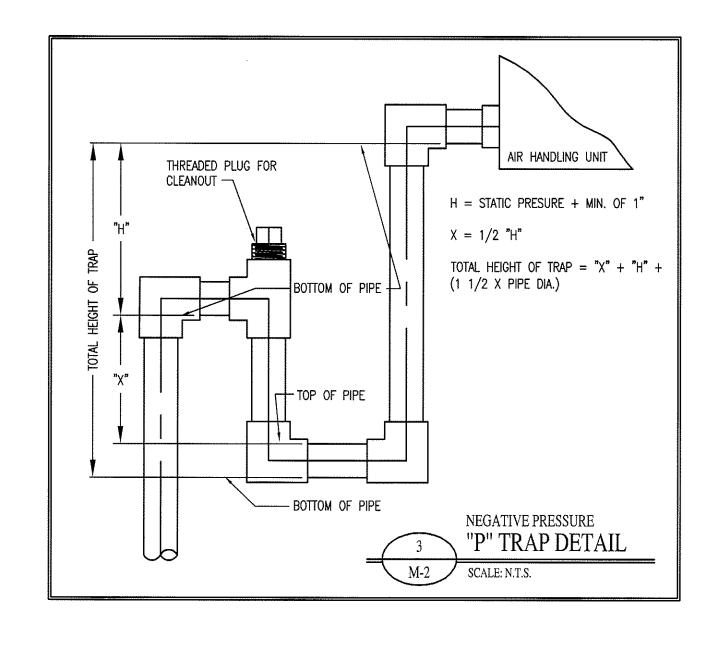

SPIN COLLAR DUCT
SEALER
HAND VOLUME DAMPER CLAMP
FLEXIBLE ROUND DUCT
BRANCH DUCT TAKE-OFF DETAIL M-2 SCALE: N.T.S.


MAIN DUCT


			AIR DI	STRIBUTI	ON SCI	HEDULE			
MARK	MANUFACTURER	NECK SIZE	PANEL SIZE	CFM RANGE	USE	TYPE	MODEL	MATERIAL	FILTER SIZE
A	E.H. PRICE	6 " ø	24x24	0–150	SUPPLY	STAMPED LOUVER FACE	SCD	STEEL	_
В	E.H. PRICE	8"ø	24x24	151-250	SUPPLY	STAMPED LOUVER FACE	SCD	STEEL	
С	E.H. PRICE	10"ø	24x24	251-375	SUPPLY	STAMPED LOUVER FACE	SCD	STEEL	-
D	E.H. PRICE	12 " ø	24x24	376-550	SUPPLY	STAMPED LOUVER FACE	SCD	STEEL	
E	E.H. PRICE	-	16x6	201-300	SUPPLY	SIDEWALL REGISTER	520D	STEEL	
F	E.H. PRICE	20x20	24x24	0-800	return	return Filter Grille	530FF	STEEL	20x20
G	E.H. PRICE	-	20x14	0-790	RETURN	return Filter Grille	530FF	STEEL	18x12
Н	E.H. PRICE		26x26	0-1150	RETURN	return Filter Grille	530FF	STEEL	24x24
J	E.H. PRICE	22x22	24x24	0-1600	RETURN	non-filtered return grille	530	STEEL	

								PA	CKAGED (GAS UNIT	SCHEDULE						
MARK	MANUFACTURER	MODEL NO.	TONS	POWER	MCA	WCD.		,	FAN DATA			CC	OOLING CAPACITY		HE	EATING CAPACITY	
MININ	MANOI ACIONEIX	MODEL NO.	10113	FOHER	MCA	MICD	AIR FLOW (CFM)	R.A. FLOW (CFM)	O.A. FLOW (CFM)	E.S.P. (IN. W.G.)	MOTOR SIZE (H.P.)	SENSIBLE (BTUH)	TOTAL (BTUH)	MIN. EFF.	INPUT (BTUH)	OUTPUT (BTUH)	MIN. EFF.
<u>RTU-1</u>	TRANE	YSC120A3	10	208V/3ø	52.6	60	4000	3280	720	0.50	5.0	111,400	124,200	10.2 SEER	175,000	141,800	81%
RTU-2	TRANE	YSC060E3	5	208V/3ø	29.5	45	2000	1575	425	0.50	1.0	61,800	67,200	13.0 SEER	130,000	104,000	80%
<u>RTU-3</u>	TRANE	YSC090A3	7.5	208V/3ø	42.7	60	3000	2470	530	0.50	3.0	84,400	98,500	10.1 SEER	140,000	113,000	81%
RTU-4	TRANE	YSC072A3	6	208V/3ø	32.7	50	2400	1945	455	0.50	1.0	53,600	72,000	10.3 SEER	120,000	97,200	81%
<u>RTU-5</u>	TRANE	YSC090A3	7.5	208V/3ø	42.7	60	3000	2575	425	0.50	3.0	84,400	98,500	10.1 SEER	140,000	113,000	81%
* UNITS TO BE	EQUIPPED WITH ON-	-ROARD BREAKE	R OR F	TISED DISC	ONNECT		-			-			<u> </u>				

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*	UNITS	TO	BE	EQUIPPED	WITH	ON-BOA	RD CONVENIEN	ICE RECE	PTACLES,	FACTORY	ROOF	CURBS,	AND	OUTSIDE	AIR	DAMPERS

	UNIT	HEATER S	CHEDU	JLE		
MARK	MANUFACTURER	MODEL NO.	втин	WATTS	POWER	AMPS
UH-1	QMARK	WHT-500	1,708	500	120V/1ø	4.2

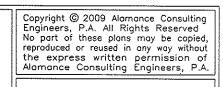

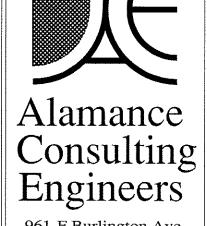

961-F Burlington Ave. Gibsonville, N.C. 27249 Phone: (336) 449-4558 Fax: (336) 449-5732

Skidmore, Inc.

eneral Contractor


92-1088 Post Office Box 19328
94-2859 Greensboro, N.C. 27419

A. KING

DRAWING NAME

MECHANICAL

DETAILS

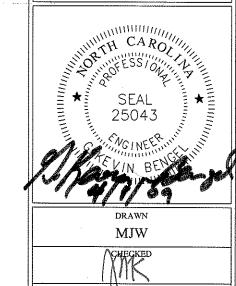

DATE
//1/09
SCALE
AS NOTED
JOB NO.
9024

M-2

